

ROOF REPLACEMENT FOR CIRCUIT COURT

900 COURT STREET,
LYNCHBURG, VIRGINIA

LYNCHBURG CITY PROJECT NO. BR037.0140



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ROOF REPLACEMENT
CIRCUIT COURT
LYNCHBURG, VA PROJECT NUMBER: 15189

ABBREVIATIONS

AB ANCHOR BOLT	EVC ELECTRIC WATER COOLER	MAS MASONRY	RG RETURN GRILLE
ABV ABOVE	EXH EXHAUST	MATL MATERIAL	RM ROOM
ACST ACOUSTIC	EXST EXISTING	MAX MAXIMUM	RO ROUGH OPENING
ACT ACOUSTICAL CEILING TILE	EXP EXPOSED	MCT MARMOLEUM COMPOSITE TILE	RU ROLL UP
AFF ABOVE FINISHED FLOOR	EXPN EXPANSION	MDF MEDIUM DENSITY FIBERBOARD	S SOLID, SOUTH SWITCH
AGGR AGGREGATE	EXT EXTERIOR	MECH MECHANICAL	SA STATUS ALARM, SUPPLY AIR
AHR ANCHOR	FLA FLASHING & WEEPS	MEZZ MEZZANINE	SCF STEEL CHANNEL FRAME
AL ALUMINUM	FF FFACE TO FACE	MFR MANUFACTURER	SCHE D SCHEDULE
APC ARCHITECTURAL PRECAST	FD FLOOR DRAIN	MIN MINIMUM	SECT SECTION
APPROX APPROXIMATE	FDN FOUNDATION	MISC MISCELLANEOUS	SQ SQUARE FEET (FOOT)
ARCH ARCHITECTURAL	FIN FINISHED	MO MASONRY OPENING	SG SUPPLY GRILLE
AVG AVERAGE	FL FLOOR	MOH MASONRY OPENING HEIGHT	SGF STRUCTURAL GLAZED FACED UNITS
BD BOARD	FRP FIBERGLASS REINFORCED POLYESTER	MOV MASONRY OPENING WIDTH	SH SHEET
BET BETWEEN	FRT FIRE RETARDANT TREATED	MT MOUNT	SM SIMILAR
BLDG BUILDING	FT FOOT (FEET)	MTL METAL	SLP SLOPE
BLK BLOCKING	FTG FOOTING	MUL MULLION	SNT SEALANT
BM BEAM	FUT FUTURE	MWP MEMBRANE WATERPROOFING	SPEC SPECIFICATION(S)
BOT BOTTOM	GA GAGE	N NORTH	SPR SPRAY POLYURETHANE FOAM INSULATION
BRG BEARING	GAL GALLON	NC NOT IN CONTRACT	SPM SINGLE PLY MEMBRANE
BUR BUILT-UP ROOF(ING)	GALV GALVANIZED	NO NUMBER	SQ SQUARE
C/C CENTER TO CENTER	GL GLASS	NOM NOMINAL	SST STAINLESS STEEL
CFMF COLD FORMED METAL FRAMING	GRTG GRATING	NST NONSLIP TREAD	STC SOUND TRANSMISSION COEFFICIENT
CFS COLD FORMED STEEL	GWB GYPSUM WALLBOARD	NTS NOT TO SCALE	STD STANDARD
CP CAST-IN-PLACE, CAST IRON PIPE	GYP GYPSUM	O/O OUT TO OUT	STL STEEL
CJ CONTROL JOINT	H HEIGHT, HIGH	OAH OVERALL HEIGHT	STO STORAGE
CL CENTER LINE	HB HOSE BIB	OD OVERALL WIDTH	STRUCT STRUCTURAL
CLG CEILING	HBD HARDBOARD	OC ON CENTER	SUSP SUSPENDED
CLR CLEAR	HC HANDICAPPED	OD OUTSIDE DIAMETER	SYM SYMMETRICAL
CMU CONCRETE MASONRY UNIT	HDW HARDWARE	OFCI OWNER FURNISHED CONTRACTOR INSTALLED	SYS SYSTEM
COL COLUMN	HM HOLLOW METAL	OFF OFFICE	T&G TONGUE & GROOVE
COMP COMPOSITE	HMD HOLLOW METAL DOOR	OFOI OWNER FURNISHED OWNER INSTALLED	TSTAT THERMOSTAT
CONC CONCRETE, CONCENTRATED	HMF HOLLOW METAL FRAME	OH OVERHEAD	TEL TELEPHONE
CONN CONNECT(ED), CONNECTION	HOR HORIZONTAL	OPN OPENING	THK THICKNESS
CONSTR CONSTRUCTION	HPT HIGH POINT	OPP OPPOSITE	THR THRESHOLD
CONT CONTINUATION, CONTINUOUS, CONTROL	HR HANDRAIL	PI PIPES/METER INSULATION	TOJ TOP OF JOIST
COORD COORDINATE	HT HEIGHT	PL PLATE	TOS TOP OF STEEL
CORR CORRIDOR, CORRUGATED	HVAC HEATING, VENTILATING & AIR CONDITIONING	PLAM PLASTIC LAMINATE	TOT TOTAL
CT CERAMIC TILE	HW HOT WATER	PLAS PLASTER	TRD TREAD
CTNG COATING	ID INSIDE DIAMETER	PLYW PLYWOOD	TRTD TREATED
CTR CENTER	IN INCH	PNLG PANELING	TYP TYPICAL
CTSK COUNTERSUNK	INCL INCLUSIVE	PR PAR	UN UNLESS OTHERWISE NOTED
D DEPTH, DEEP	INST INSTALL(ED)	PSF POUNDS PER SQUARE FOOT	UTL UTILITY
DBL DOUBLE	INSUL INSULATE(ED)(ING)(ON)	PSI POUNDS PER SQUARE INCH	VCT VINYL COMPOSITION TILE
DEPT DEPARTMENT	INT INTERIOR	PT PRESSURE TREATED, POINT, POINT OF TANGENT	VENT VENTILATE
DET DETAIL(ED)	INT-M INTERMEDIATE	PAR PARTITION	VERT VERTICAL
DIA DIAMETER	ISOL ISOLATION	PVC POLYVINYL CHLORIDE, POINT OF VERTICAL CURVE	VEST VESTIBULE
DIAG DIAGONAL, DIAGRAM	JAN JANITOR	QT QUARRY TILE	VIF VERIFY IN FIELD
DM DIMENSION	JST JOIST	R RADIUS, REACTION, RISER, RESISTANCE	VTR VENT THRU ROOF
DK DECK	JT JOINT(S)	RA RETURN AIR	VWC VINYL WALL COVERING
DN DOWN	KOP KNOCK OUT PANEL	RAF RESILIENT ATHLETIC FLOORING	W WEST
DOH DOOR OPENING HEIGHT	L LENGTH, LINE, LONG	RCP REFLECTED CEILING PLAN	W/ WITH
DOW DOOR OPENING WIDTH	LAB LABORATORY	RCPT RECEPTACLE(S)	W/O WITHOUT
DP DAMPPROOFING	LAM LAMINATE	REF REFERENCE	WC WATER CLOSET, WATER COLUMN
DR DOOR	LAV LAVATORY	REIN REINFORCEMENT(ING)	WD WOOD
DS DOWNSPOUT	LB FOUND	REQD REQUIRED	WDO WINDOW
DWG DRAWING	LF LINEAR FOOT	REQM REQUIREMENT(S)	WOH WINDOW OPENING HEIGHT
E EAST	LG LENGTH, LONG	RESL RESILIENT	WOW WINDOW OPENING WIDTH
EA EACH	LIN LINEAR	RET RETURN	WP WEATHERPROOF, WORKING POINT
EFIS EXTERIOR INSULATION FINISH SYSTEM	LL LIVE LOAD	REV REVERSE ACTING, REVISED, REVISION	WRGWB WATER RESISTANT GYPSUM WALLBOARD
EJ EXPANSION JOINT	LLV LONG LEG VERTICAL	RF RETURN FAN, ROOF	WWF WELDED WIRE FABRIC
EL ELEVATION	LOC LOCATION		
ELEC ELECTRIC(AL)	LONG LONGITUDINAL		
ELEV ELEVATOR, ELEVATION	LPT LOW POINT		
ENCL ENCLOSE(URE)	MACH MACHINE		
EQ EQUAL			
EQPT EQUIPMENT			

ARCHITECT

ARCHITECTURAL PARTNERS P.C.


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SITE MAP



DRAWING LIST

CS1.1	COVER SHEET
A1.1	ROOF PLANS
A1.2	ROOF DETAILS

SYMBOL LEGEND

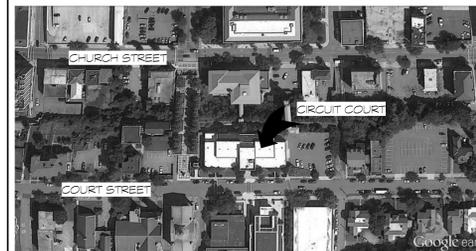	PRE CAST ARCHITECTURAL CONCRETE "APC"		FINISH WOOD
	GYPSUM WALLBOARD		PLYWOOD
	BRICK OR MASONRY VENEER		CONCRETE
	CONCRETE MASONRY UNITS "CMU"		CRUSHED STONE BASE MATERIAL
	RIGID INSULATION		EARTH
	BATT INSULATION		STEEL
	COLUMN TAG		ELEVATION MARKER
	WALL TYPE TAG		DOOR TAG
	GENERAL NOTE TAG		DETAIL REFERENCE SYMBOL
	LOUVER TAG		FINISH SCHEDULE TAG
	WINDOW TAG		INTERIOR ELEVATION MARKER



WHEN CONTRACTING OR THESE DRAWINGS SHALL BE PROVIDED TO OTHERS, CONTRACTORS SHALL VERIFY AND BE RESPONSIBLE FOR ALL DIMENSIONS AND CONDITIONS ON THE JOB AND THIS OFFICE MUST BE NOTIFIED OF ANY VARIATION FROM THE DIMENSIONS AND CONDITIONS SHOWN BY THESE DRAWINGS.

DATE: 2016-01-15
DESIGNED: MWS/CMH
DRAWN: CMH
CHECKED: MWS
REVISIONS:

COVER SHEET

CS1.1




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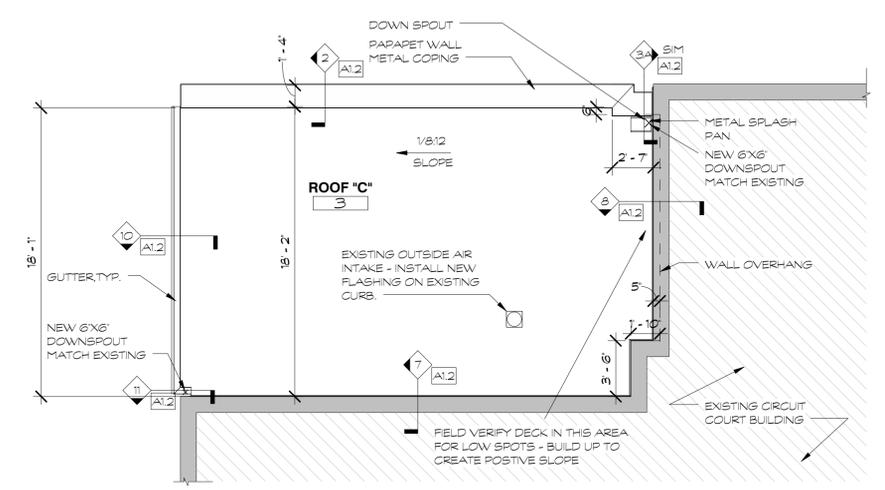
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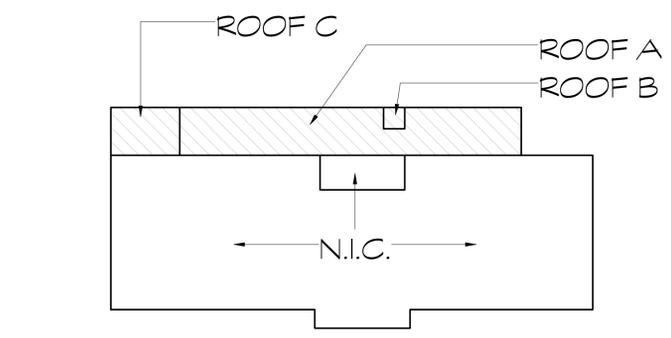


1 ROOF "A" & "B" PLAN
3/16" = 1'-0"
TRUE NORTH REF NORTH

- (X) ROOF PLAN KEY NOTES**
- 1 INSTALL 4" DIA. COPPER DOWNSPOUT WITH ELBOW FROM EXIST. CONDUCTOR HEAD TO SPLASH PAN. DOWNSPOUT LENGTH APPROX 8'-0". V.I.F. TYP. AT 4 LOCATIONS.
- GENERAL NOTES**
- 1 REMOVE MECH. UNIT TO INSTALL NEW CURB FLASHING & RE-INSTALL.

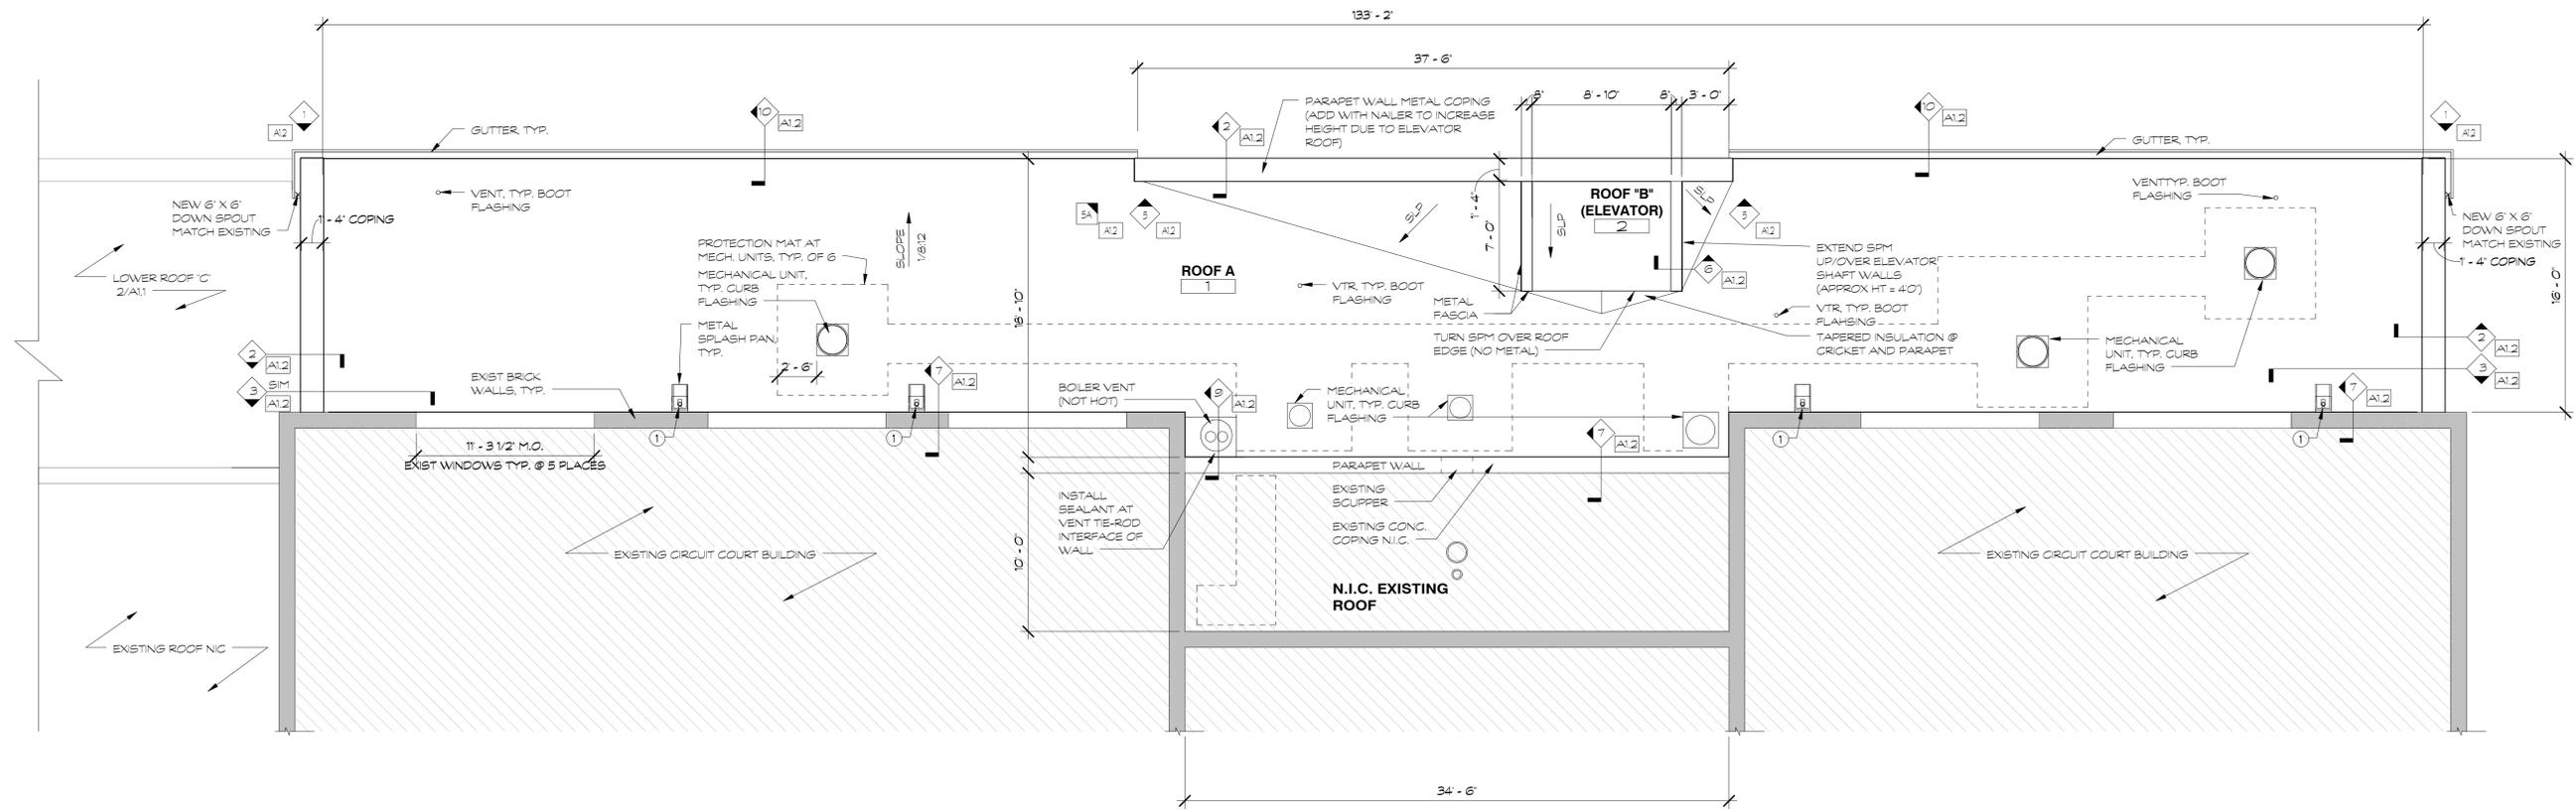

2 ROOF "C" PLAN
3/16" = 1'-0"
TRUE NORTH REF NORTH



3 KEY PLAN
1/16" = 1'-0"
TRUE NORTH REF NORTH




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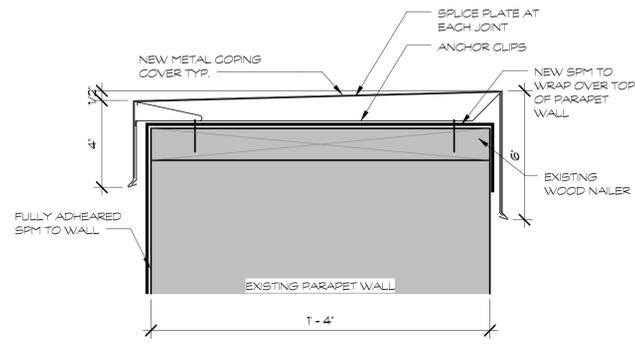
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ROOF PLANS


A1.1



1
A1.2 END WALL ELEVATION

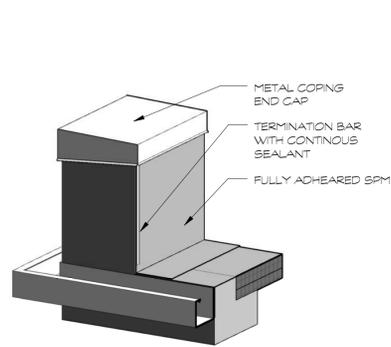


2
A1.2 COPING DETAIL
3' ± 1'-0"

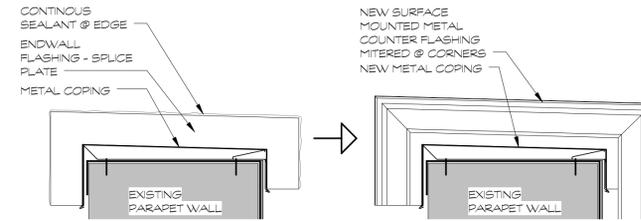


3A
A1.2 DETAIL
1 1/2' ± 1'-0"


NOTE: PROTECT ENDWALL FLASHING W/ SURFACE MOUNTED COUNTER FLASHING

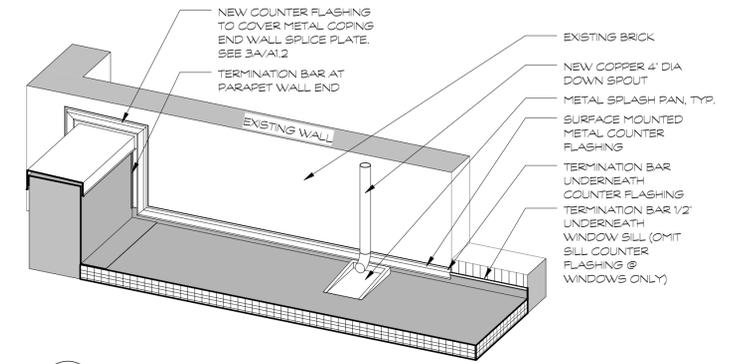


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A1.2 END WALL ELEVATION

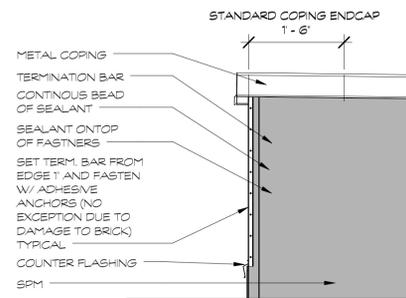


4
A1.2 NOT USED
3' ± 1'-0"

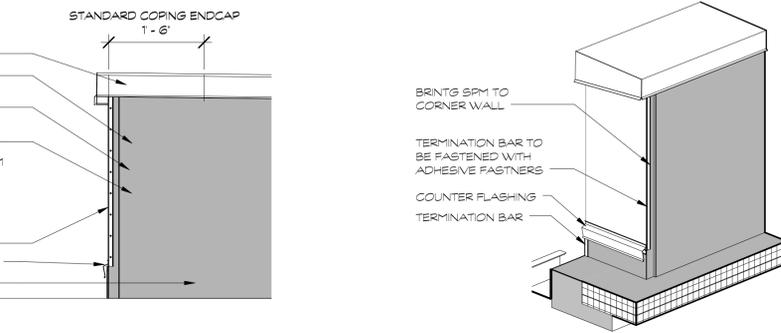

5
A1.2 END WALL ELEVATION
3/4\"/>

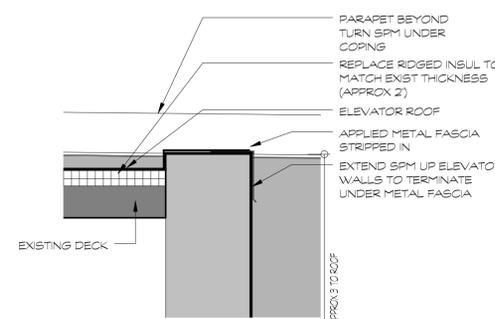


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A1.2 END WALL ELEVATION
1 1/2' ± 1'-0"

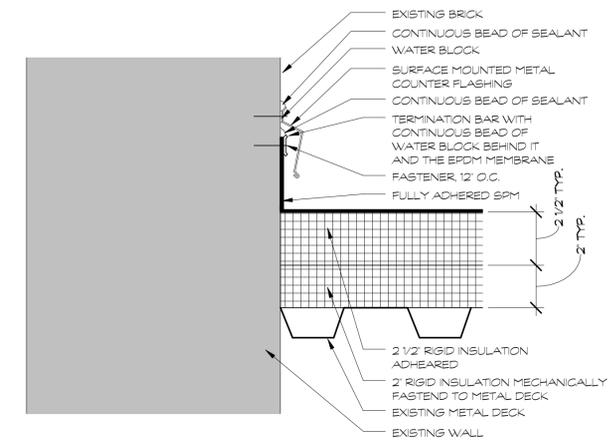


6
A1.2 WALL DETAIL
1 1/2' ± 1'-0"




7
A1.2 TERMINATION BAR AND COUNTER FLASHING DETAIL
3' ± 1'-0"

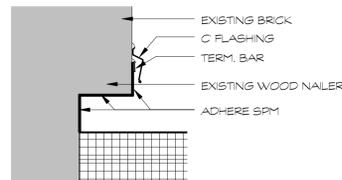


8
A1.2 DETAIL
1 1/2' ± 1'-0"

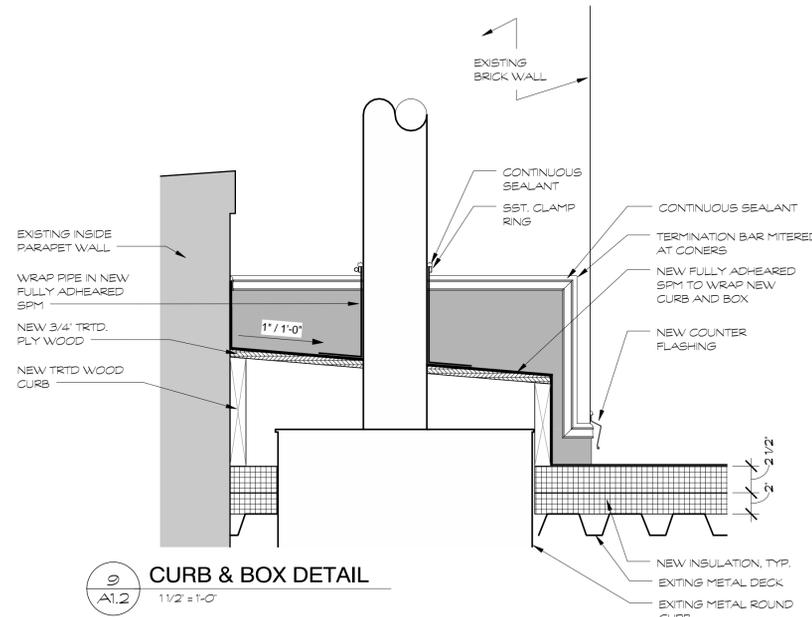

9
A1.2 CURB & BOX DETAIL
1 1/2' ± 1'-0"

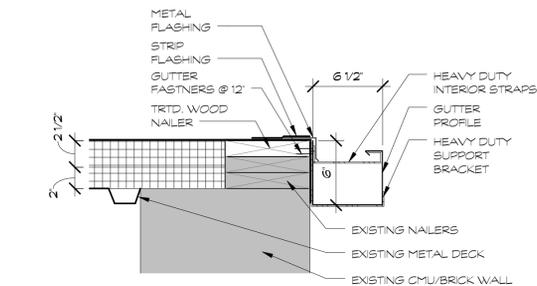

10
A1.2 GUTTER DETAIL
1 1/2' ± 1'-0"

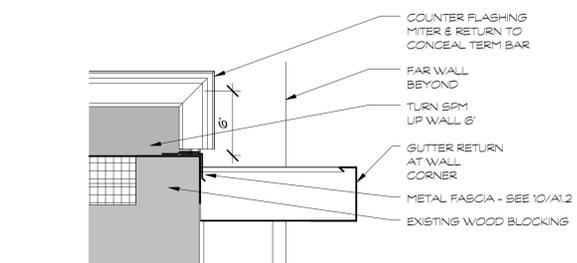

11
A1.2 DETAIL
1 1/2' ± 1'-0"



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ROOF DETAILS

A1.2